


DETAIL - LADDER DOCK


SCALE: 3" = 1'-0"

1. PAINT LADDER DOCK WITH PRIMER AND TWO COATS OF RED ENAMEL.

2. PROVIDE TWO (2) LADDER DOCKS FOR THIS PROJECT.

PLACE WHERE DIRECTED BY OWNER.

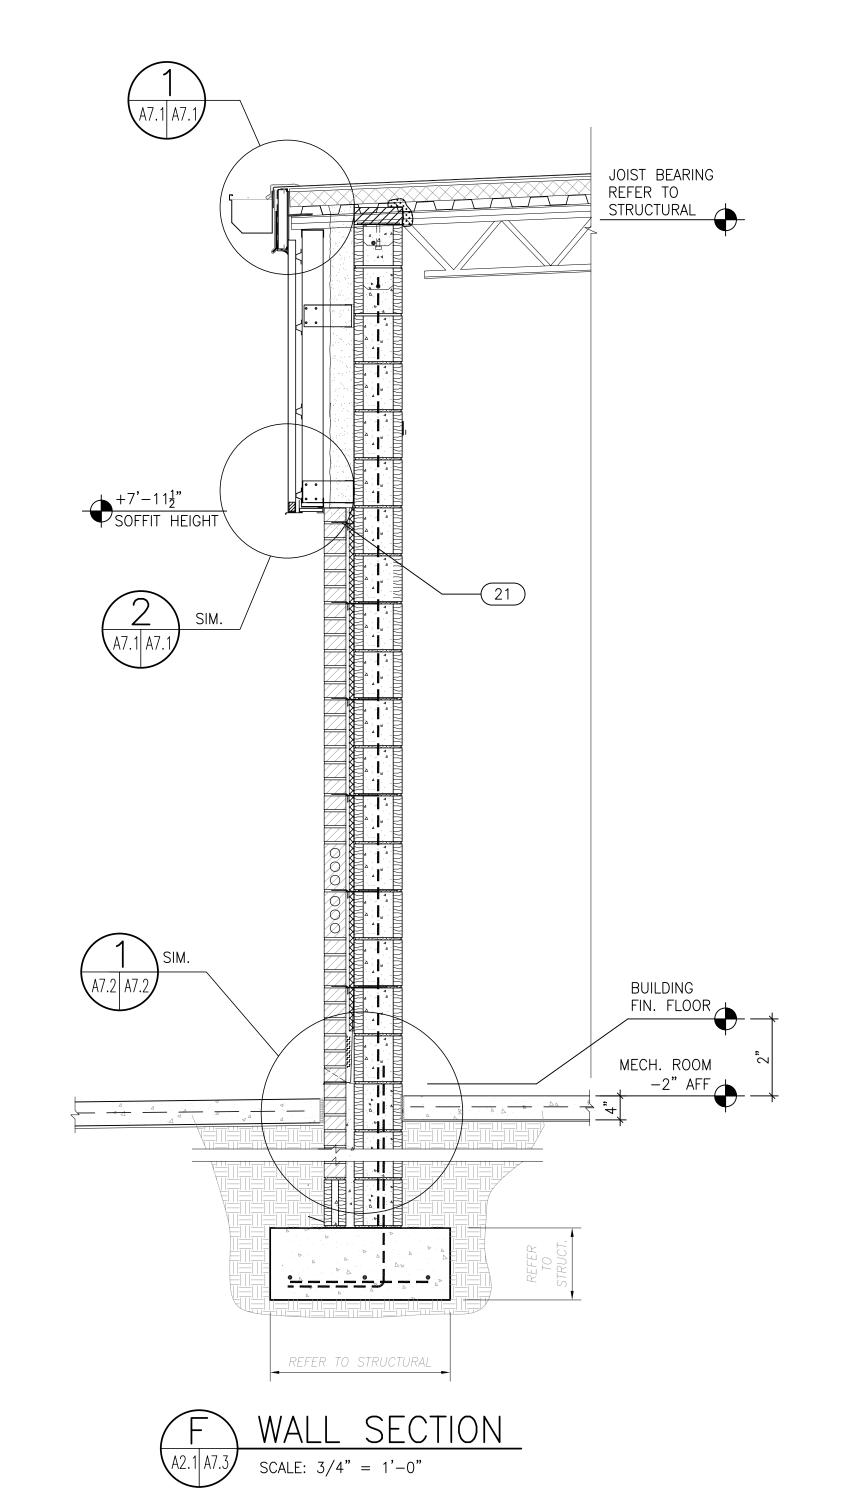

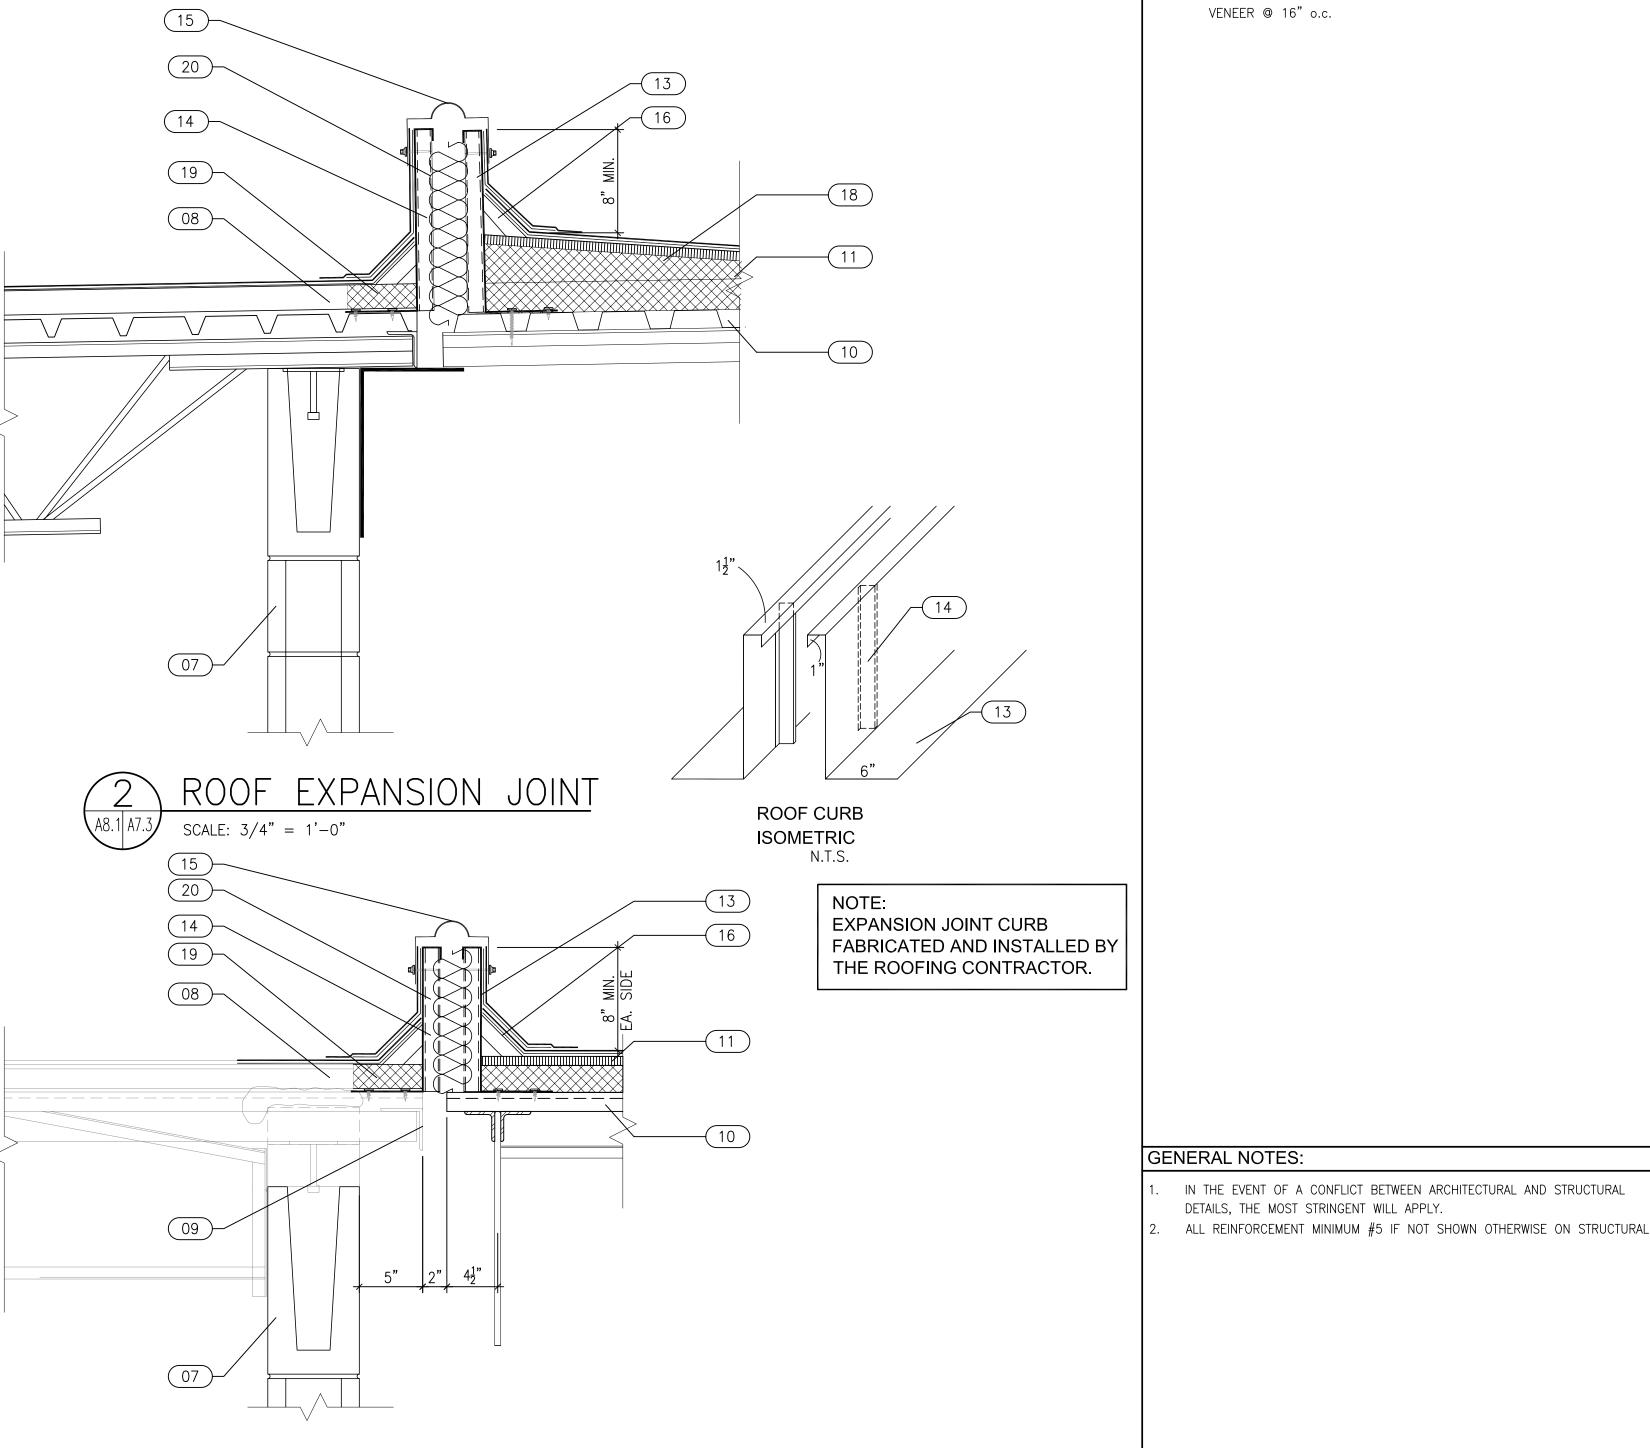

SHEET NOTES:

SYMBOL DESCRIPTION: (THESE NOTES SPECIFIC TO THIS DRAWING)

 $(01)^{\frac{1}{8}}$ " THK ALUM. LADDER DOCK BASE

02 $\frac{1}{4}$ " THK ALUM. LADDER DOCK END. WELD ALL AROUND TO BASE

03 1 $\frac{1}{4}$ " x $\frac{1}{4}$ " x $\frac{1}{4}$ " THK ANGLE SUPPORT. WELD ALL AROUND TO DOCK

04 $\frac{1}{2}$ " DIA LADDER TIE OFF HOLE. ONE IN EACH DOCK END

05 $\frac{1}{4}$ " HOLE FOR FASTENER

06 GUTTER. SEE SPECIFICATIONS FOR ADDITIONAL INFORMATION

07 EXISTING CMU WALL SYSTEM 08 EXISTING ROOF SYSTEM. REMOVE PORTION OF ROOF TO ALLOW NEW

EXPANSION CURB PLACEMENT 09 EXISTING STL ANGLE

10 ROOF DECK

11 ROOF SYSTEM

12 TAPERED INSULATION

13 20 GA. METAL EXPANSION JOINT CURB. EXPANSION JOINT CURB FABRICATED AND INSTALLED BY THE ROOFING CONTRACTOR.

14 1" x_{2}^{11} "x1" STIFFENER EVERY 12" AND @ ALL ENDS 15 CURB TO CURB EXPANSION JOINT COVER. INSTALL PER

MANUFACTURER'S INSTRUCTION

16 CANT PER ROOFING MANUFACTURERS REQUIREMENTS.

17 FASTEN CURB TO ROOF DECK w/ #10 TEK SCREWS @ 6" o.c., STAGGERED. SIZE LENGTH OF SCREWS TO FASTEN THROUGH DECKING.

18 TAPERED INSULATION

19 REMOVE EXISTING AND INFILL WITH NEW ROOF SYSTEM AFTER CURB

IN THE EVENT OF A CONFLICT BETWEEN ARCHITECTURAL AND STRUCTURAL

DETAILS, THE MOST STRINGENT WILL APPLY.

INSTALLATION. 20 INFILL WITH BATT INSULATION.

21 INSTALL CORRUGATED MASONRY TIE ONE COURSE BELOW TOP OF BRICK

VENEER @ 16" o.c.

PMA architecture

PINDER-MARTIN ASSOCIATES, INC 1001 N. 12th AVENUE PENSACOLA, FL 32501 850-439-9110

AA26000896

PROJECT: 5 CLASSROOM ADDITION LOCATION:

WEST NAVARRE INTERMEDIATE SCHOOL 1970 COTTON BAY LANE NAVARRE, FL 32566

CONSULTANTS: JEHLE-HALSTEAD INC.

49 EAST CHASE STREET PENSACOLA, FL 32502

CRAFT & WEBSTER STRUCTURAL ENGINEERING, INC.

129 HIGHPOINT DRIVE GULF BREEZE, FL 32561

GULF BREEZE CONSULTING, INC. 139 EAST GOVERNMENT STREET PENSACOLA, FL 32502

ADAMS CONSULTING ENGINEERING, INC.
3 WEST GARDEN STREET — SUITE 382
PENSACOLA, FL 32502

CLASSROOM ADDITIONS

WEST NAVARRE

INTERMEDIATE

No. Revision/Issue

DAVID J. PINDER ARCHITECT OF RECORD

AR 0010632

DRAWN BY: CHECKED BY: PINDER-MARTIN ASSOCIATES, INC. PROJECT #: 21 REVIEW: PERMITTING:

RELEASE FOR BIDDING:

WALL SECTIONS & DETAILS

A7.3

21118.04 A7_3

ROOF EXPANSION JOINT SCALE: 3/4" = 1'-0"