



3 DETAIL — LADDER DOCK
SCALE: 3" = 1'-0"
NOTE:
1. PAINT LADDER DOCK WITH PRIMER AND TWO COATS OF RED ENAMEL.
2. PROVIDE TWO (2) LADDER DOCKS FOR THIS PROJECT.
PLACE WHERE DIRECTED BY OWNER.

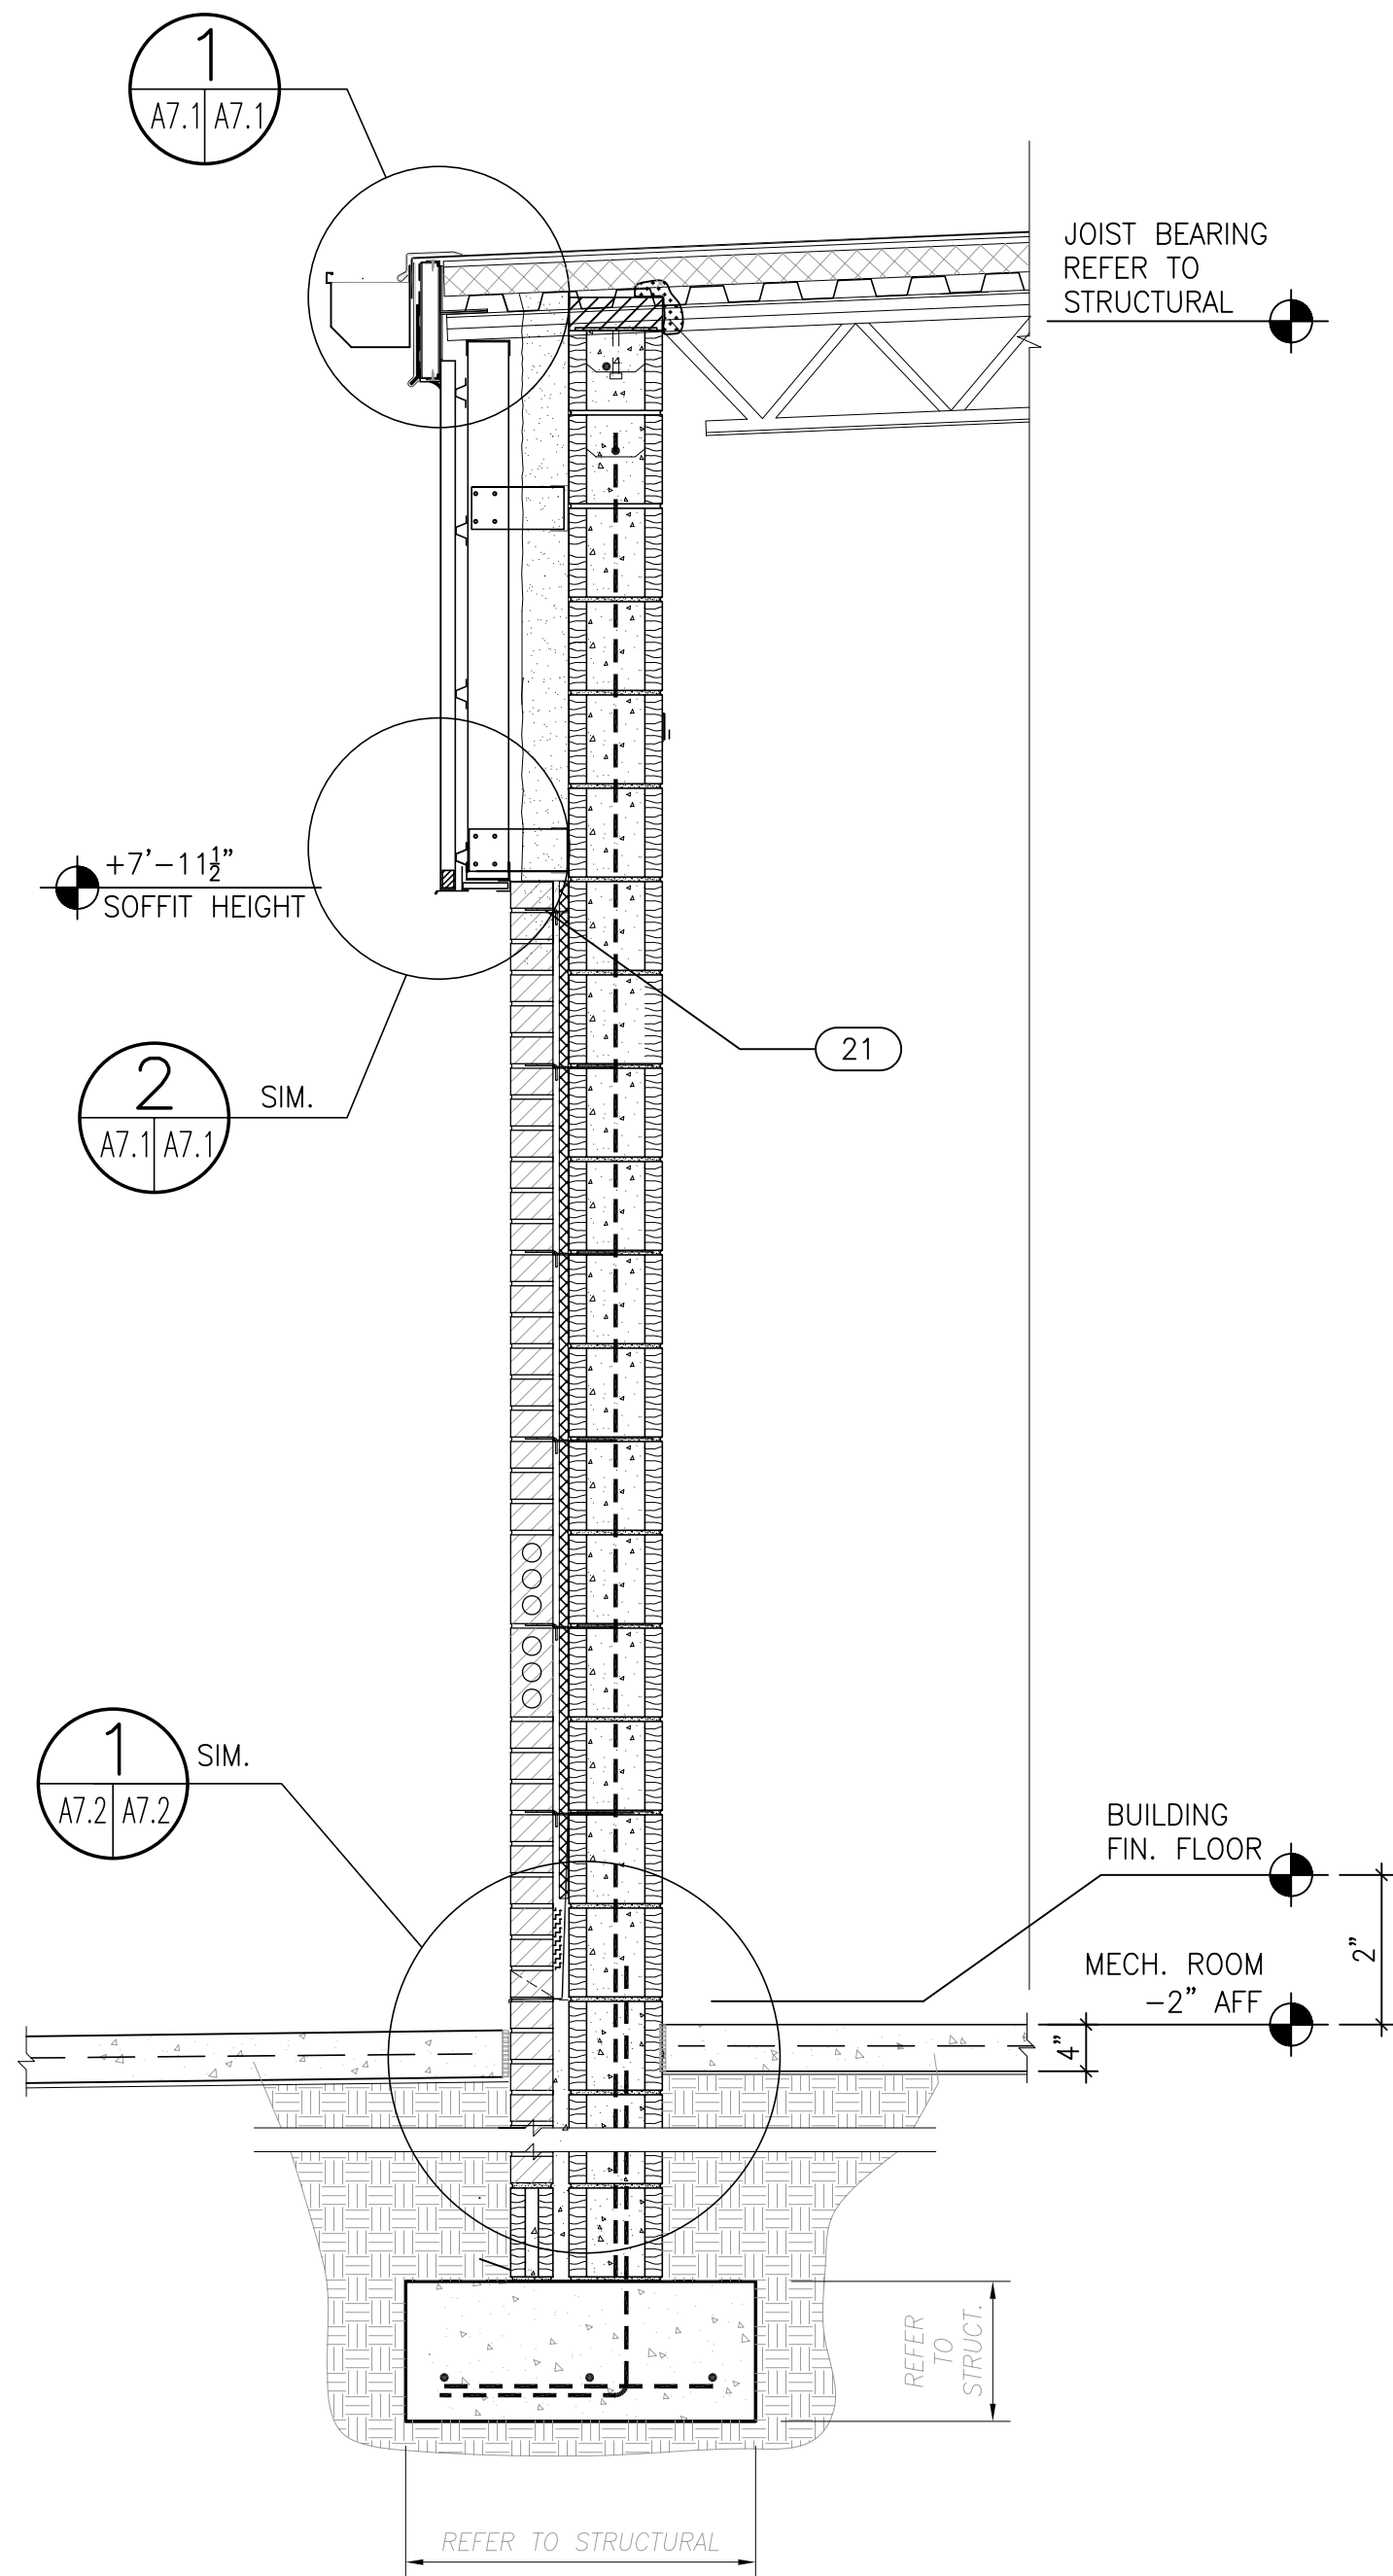

F WALL SECTION
SCALE: 3/4" = 1'-0"

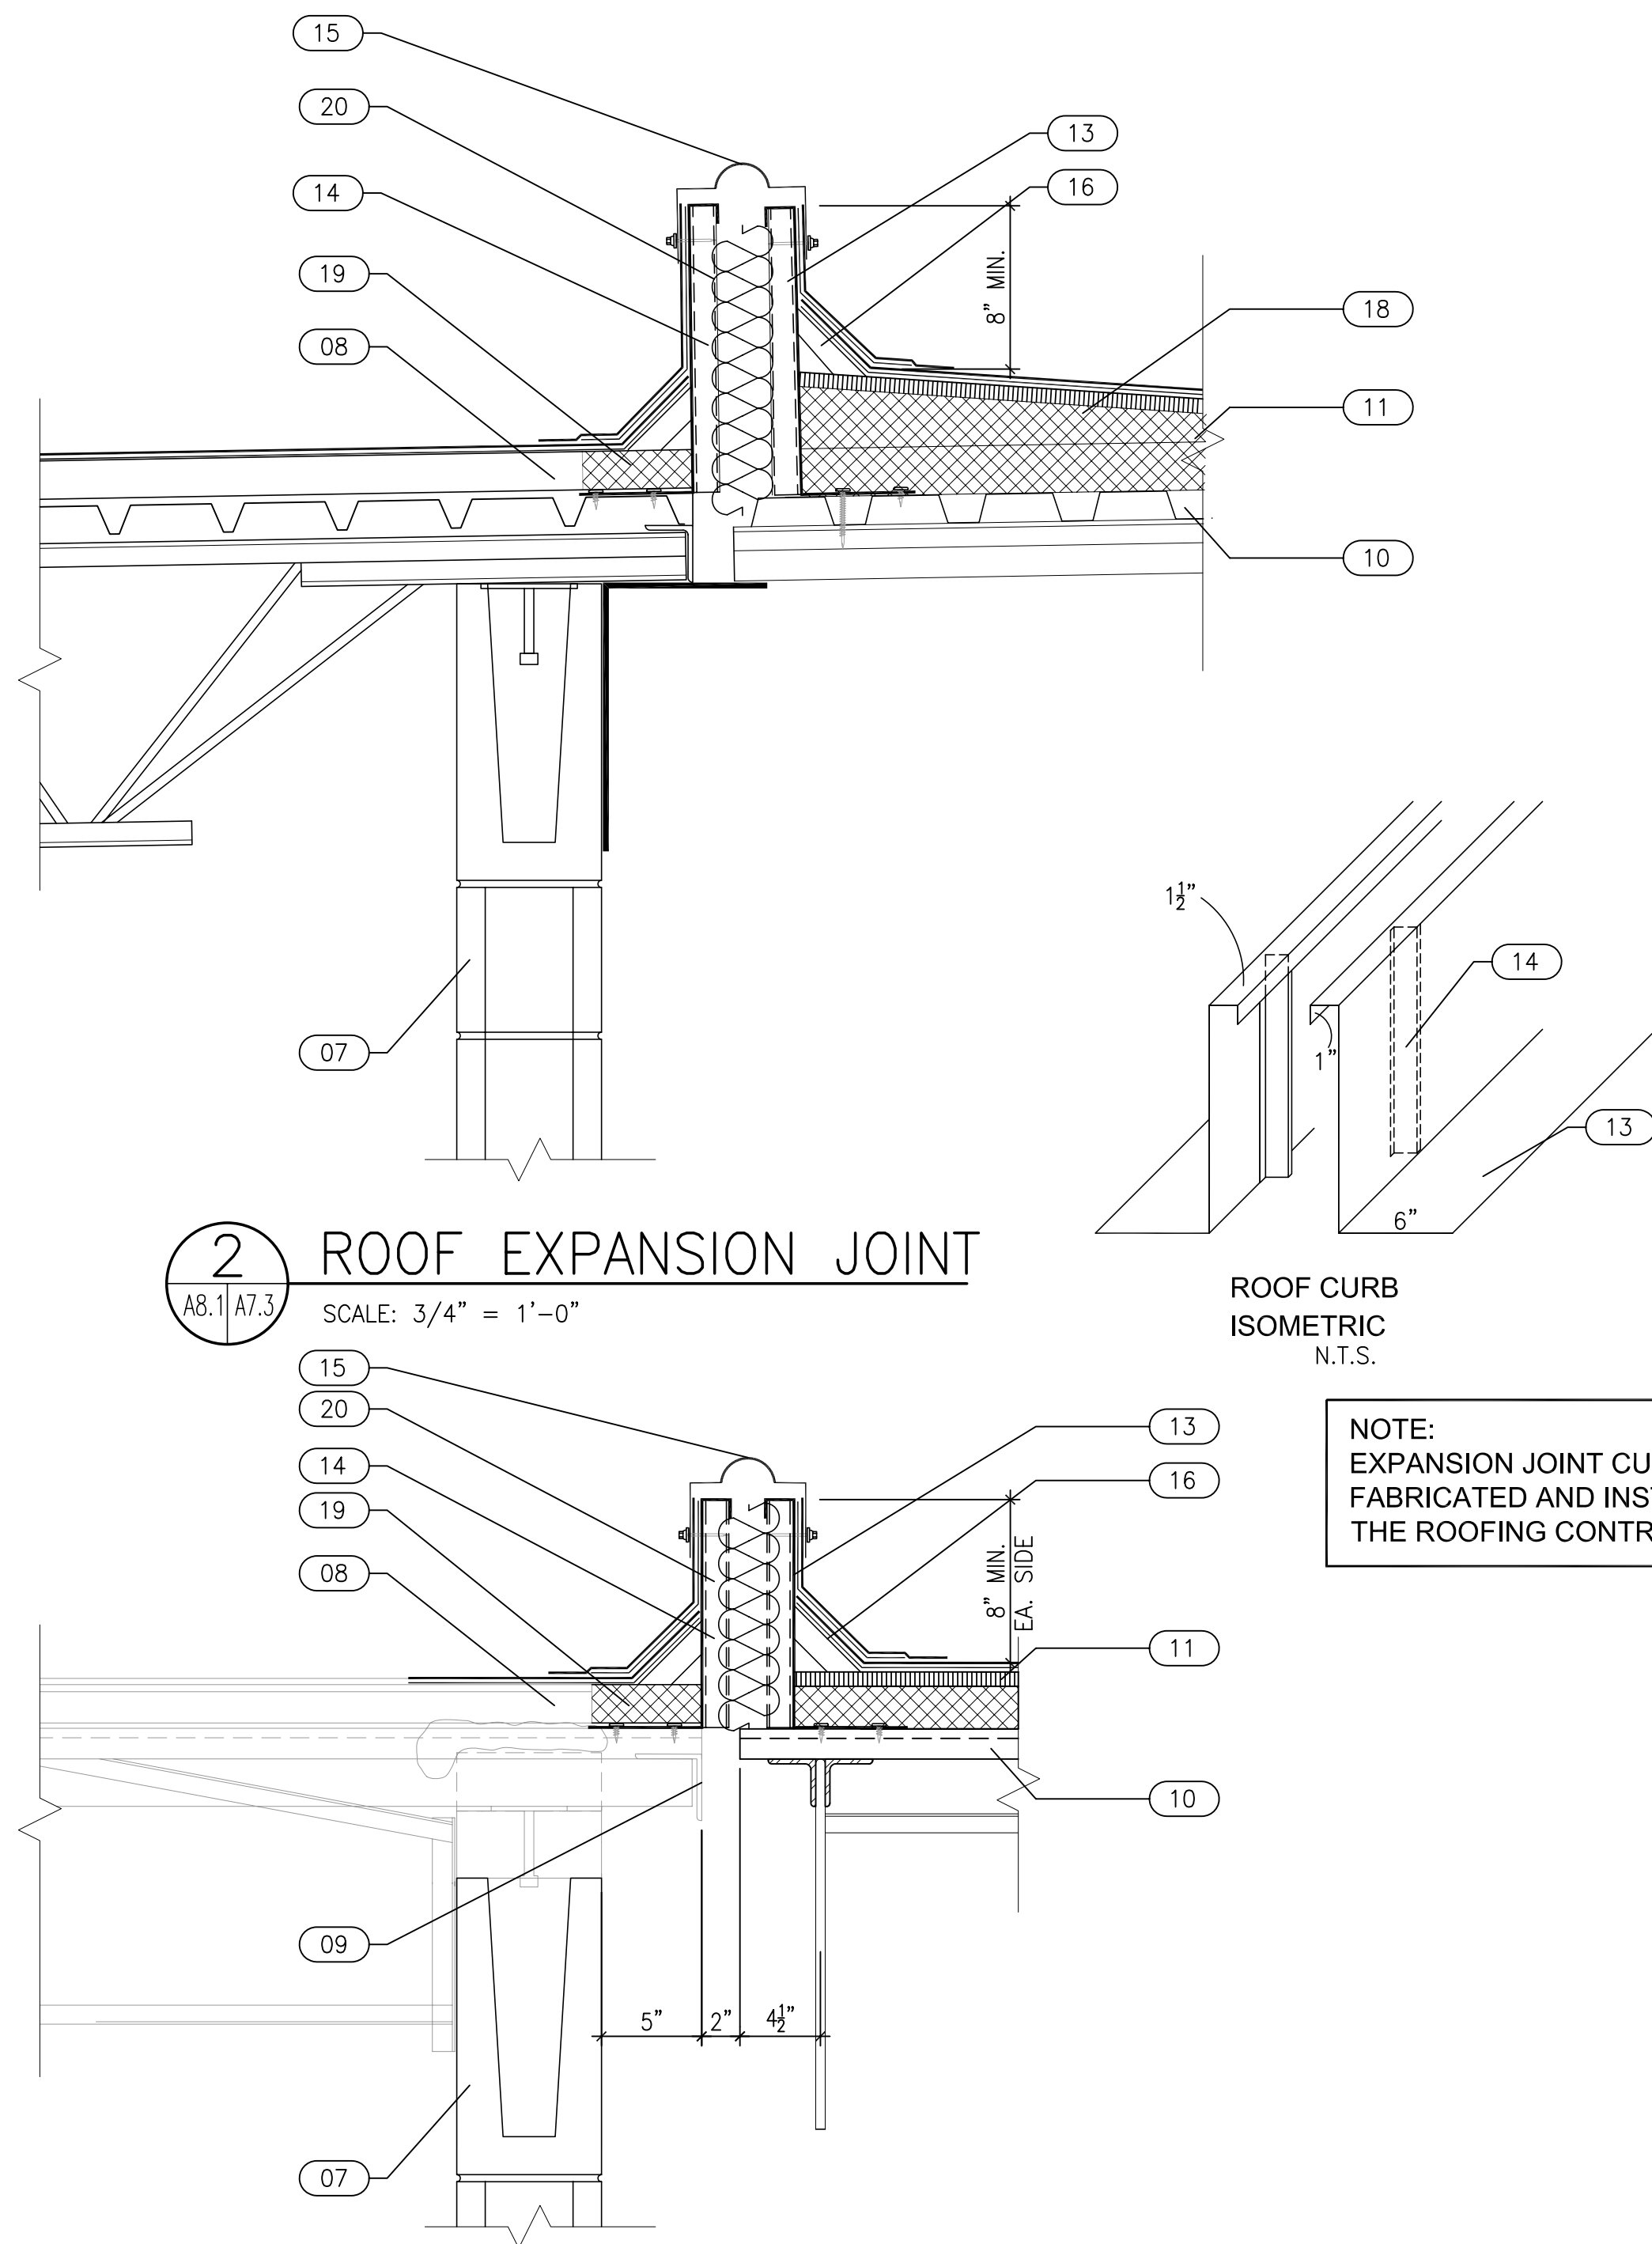

2 ROOF EXPANSION JOINT
SCALE: 3/4" = 1'-0"

1 ROOF EXPANSION JOINT
SCALE: 3/4" = 1'-0"

- SHEET NOTES:**
- SYMBOL DESCRIPTION: (THESE NOTES SPECIFIC TO THIS DRAWING)
- 01 8" THK ALUM. LADDER DOCK BASE
 - 02 1/2" THK ALUM. LADDER DOCK END. WELD ALL AROUND TO BASE
 - 03 1 1/2"x1 1/2" x 1/2" THK ANGLE SUPPORT. WELD ALL AROUND TO DOCK END
 - 04 1/2" DIA LADDER TIE OFF HOLE. ONE IN EACH DOCK END
 - 05 1/2" HOLE FOR FASTENER
 - 06 GUTTER. SEE SPECIFICATIONS FOR ADDITIONAL INFORMATION
 - 07 EXISTING CMU WALL SYSTEM
 - 08 EXISTING ROOF SYSTEM. REMOVE PORTION OF ROOF TO ALLOW NEW EXPANSION CURB PLACEMENT
 - 09 EXISTING STL ANGLE
 - 10 ROOF DECK
 - 11 ROOF SYSTEM
 - 12 TAPERED INSULATION
 - 13 20 GA. METAL EXPANSION JOINT CURB. EXPANSION JOINT CURB FABRICATED AND INSTALLED BY THE ROOFING CONTRACTOR.
 - 14 1"x1/2"x1" STIFFENER EVERY 12" AND @ ALL ENDS
 - 15 CURB TO CURB EXPANSION JOINT COVER. INSTALL PER MANUFACTURER'S INSTRUCTION
 - 16 CANT PER ROOFING MANUFACTURERS REQUIREMENTS.
 - 17 FASTEN CURB TO ROOF DECK w/ #10 TEK SCREWS @ 6" o.c., STAGGERED. SIZE LENGTH OF SCREWS TO FASTEN THROUGH DECKING.
 - 18 TAPERED INSULATION
 - 19 REMOVE EXISTING AND INFILL WITH NEW ROOF SYSTEM AFTER CURB INSTALLATION.
 - 20 INFILL WITH BATT INSULATION.
 - 21 INSTALL CORRUGATED MASONRY TIE ONE COURSE BELOW TOP OF BRICK VENEER @ 16" o.c.

- GENERAL NOTES:**
- 1. IN THE EVENT OF A CONFLICT BETWEEN ARCHITECTURAL AND STRUCTURAL DETAILS, THE MOST STRINGENT WILL APPLY.
 - 2. ALL REINFORCEMENT MINIMUM #5 IF NOT SHOWN OTHERWISE ON STRUCTURAL.

PINDER-MARTIN ASSOCIATES, INC.
1001 N. 12th AVENUE
PENSACOLA, FL 32501
850-439-9110
AA26000896

PROJECT:
5 CLASSROOM ADDITION

LOCATION:
WEST NAVARRE INTERMEDIATE SCHOOL
1970 COTTON BAY LANE
NAVARRE, FL 32566

CONSULTANTS:
JEHL-HALSTEAD, INC.
49 EAST CHASE STREET
PENSACOLA, FL 32502
CRAFT & WEBSTER
STRUCTURAL ENGINEERING, INC.
129 HIGHPOINT DRIVE
GULF BREEZE, FL 32561
GULF BREEZE CONSULTING, INC.
139 EAST GOVERNMENT STREET
PENSACOLA, FL 32502
ADAMS CONSULTING
ENGINEERING, INC.
3 WEST GARDEN STREET - SUITE 382
PENSACOLA, FL 32502

NEW CLASSROOM ADDITIONS

WEST NAVARRE INTERMEDIATE

No.	Revision/Issue	Date

DAVID J. PINDER
ARCHITECT OF RECORD
AR 0010832

DRAWN BY: djp/dcp
CHECKED BY:
PINDER-MARTIN ASSOCIATES, INC.
PROJECT #: 21118.03
REVIEW: 09-06-11
PERMITTING: 09-09-11
RELEASE FOR BIDDING: 09-19-11

WALL SECTIONS & DETAILS

A7.3
21118.04 A7.3